CONTENT:	PAGE NO
Site Development Plan Ground Floor Plan First Floor Plan Ground Floor Plan Dimensioned First Floor Plan Dimensioned Elevations Elevations Cross Sections Cross Sections Cross Sections Cross Sections Foundation Plan and Details Floor Joist Layout Bracing and Electrical Plan Drainage and Site Plan Isometric Plumbing	1 2 3 4 5 6 7 8 9 10 11 12 13 14 15
Brickwork Details Brickwork Details Junction and W'board Details W'board Details Roofing Details Roofing and Wet area Details	D1 D2 D3 D4 D5 D6

LOT 65 - DP 392290, 32 ALPERS RIDGE, RIVER GARDENS, CAMBRIDGE.



Proposed: Lot 65 — DP 392290, 32 Alpers Ridge, River Gardens, Cambridge.

Drawing Name:

Amendments:	Date: June 2013	No:
	Scale:	© COPYRIGHT







Proposed: Lot 65 — DP 392290, 32 Alpers Ridge, River Gardens, Cambridge.

RL 55.00

Drawing Name: Site Plan

Amendments:	Date: June 2013	No: 1
	Scale: 1:100	© COPYRIGHT

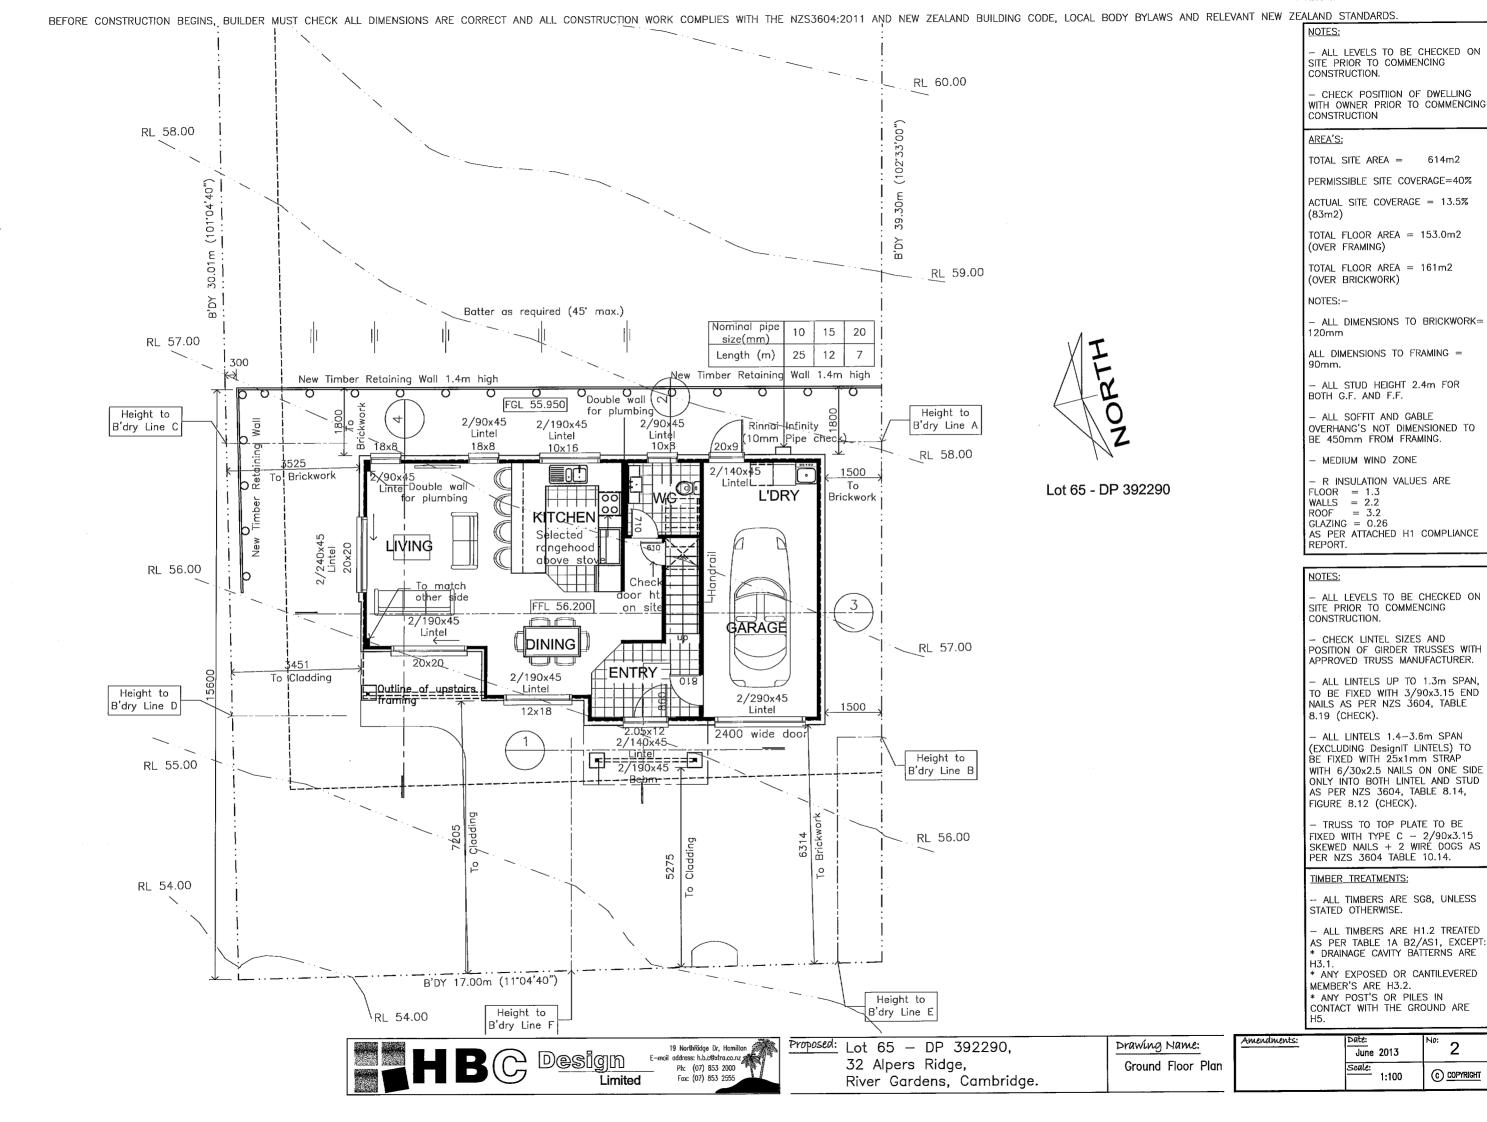

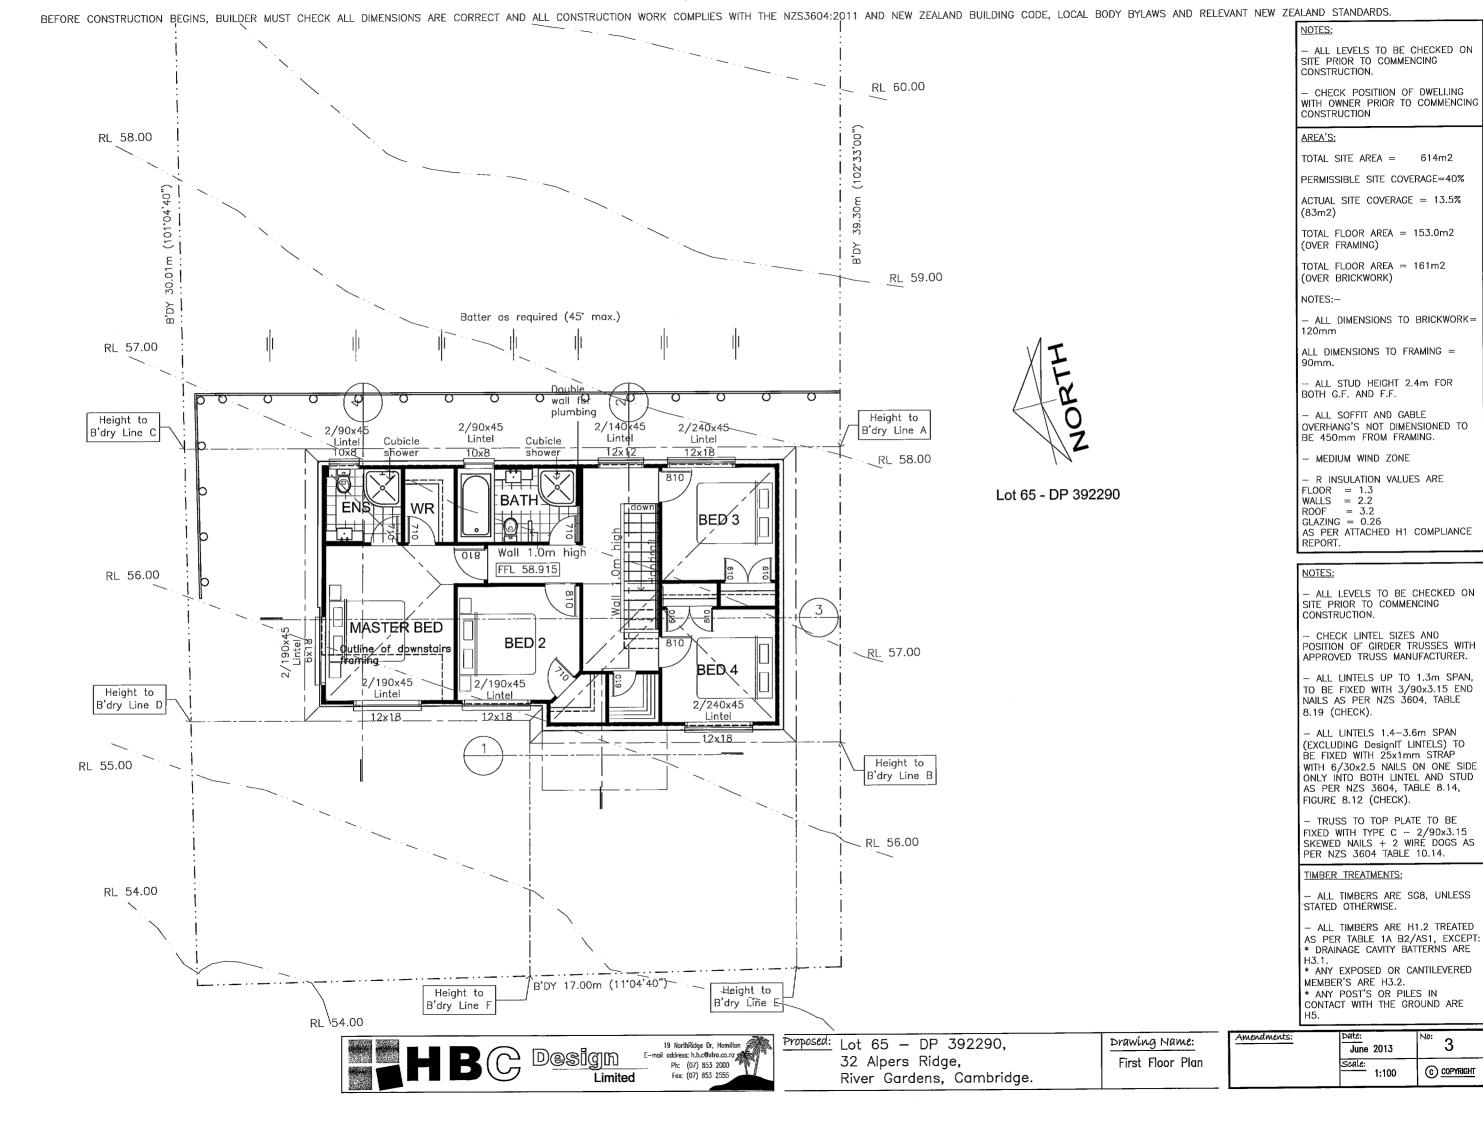


614m2

3

© COPYRIGHT

1:100

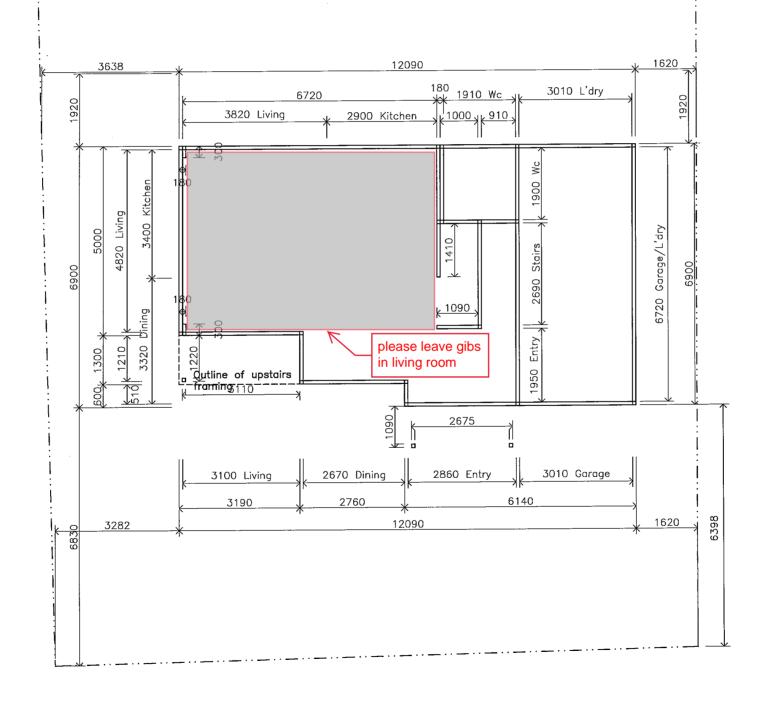

AREA'S:

G. FLOOR AREA = 76m2 F. FLOOR AREA = 77m2 T. FLOOR AREA = 153m2 (OVER FRAMING)

NOTE:

- ALL DIMENSIONS TO FRAMING = 90mm




Proposed: Lot 65 — DP 392290, 32 Alpers Ridge, River Gardens, Cambridge.

Drawing Name:

Ground Floor Plan
Dimensioned

tmendments:	Date: June 2013	No: 4
	Scale: 1:100	© COPYRIGHT

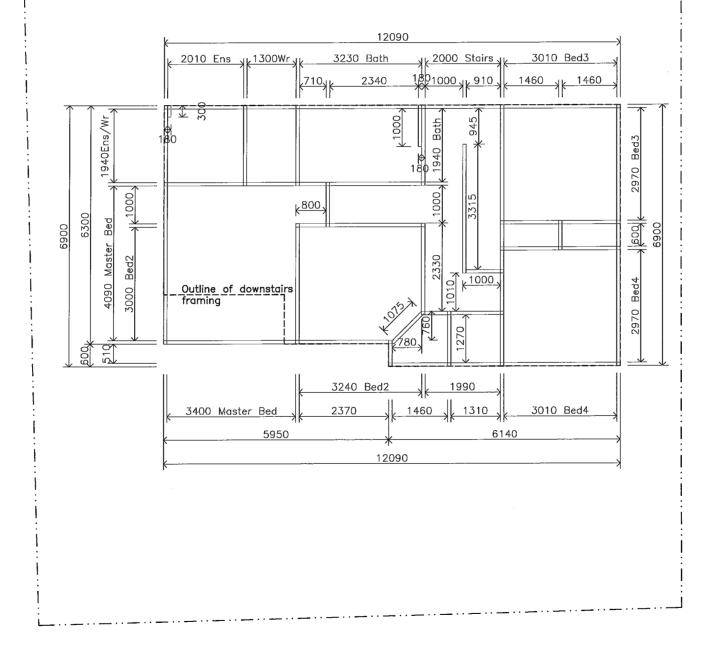

AREA'S:

G. FLOOR AREA = 76m2 F. FLOOR AREA = 77m2 T. FLOOR AREA = 153m2 (OVER FRAMING)


- ALL DIMENSIONS TO FRAMING = 90mm



Proposed: Lot 65 - DP 392290, 32 Alpers Ridge, River Gardens, Cambridge.

Drawing Name: First Floor Plan Dimensioned

Amendments:	June 2013	No: 5
	Scale: 1:100	© COPYRIGHT

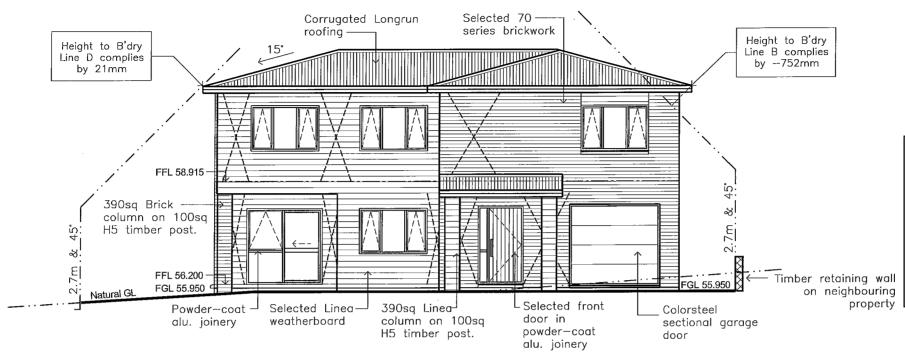


NOTE:

- ALL LEVELS TO BE CHECKED ON SITE PRIOR TO COMMENCING CONSTRUCTION

-ALL SAFETY GLAZING REQUIRED AS PER NZS 4223 AND WINDOW SCHEDULE.

-ALL GLAZING TO BE DOUBLE GLAZED TO A MINIMUM OF RO.26, AS PER TABLE 1 IN CLAUSE H1 (EXCEPT THE GARAGE, PROVIDED THE INTERMEDIATE WALL BETWEEN GARAGE AND HOUSE IS INSULATED TO A MINIMUM R VALUE REQUIRED FOR WALLS).

WEST ELEVATION

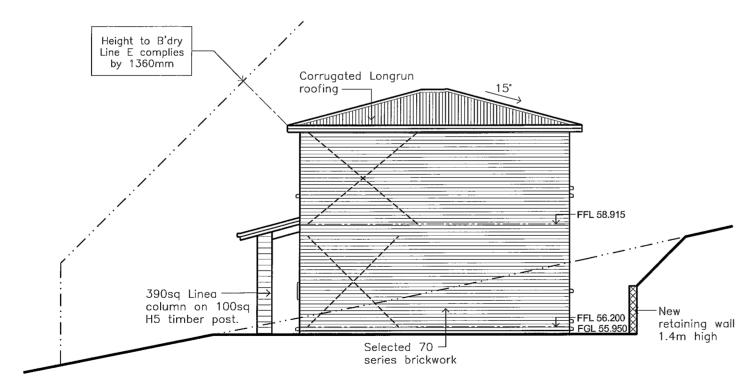


SOUTH ELEVATION



Proposed: Lot 65 — DP 392290, 32 Alpers Ridge, River Gardens, Cambridge.

Drawing Name:
ELEVATION

Amendments:	June 2013	No: 6
	Scale: 1:100	© COPYRIGHT

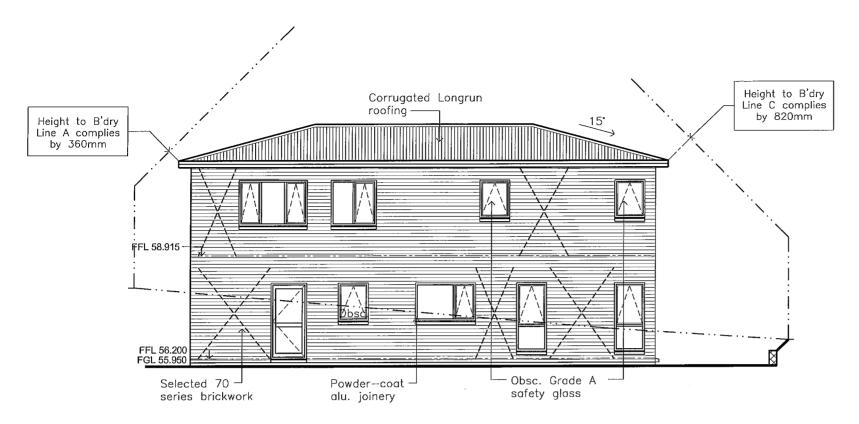


NOTE

-- ALL LEVELS TO BE CHECKED ON SITE PRIOR TO COMMENCING CONSTRUCTION

-ALL SAFETY GLAZING REQUIRED AS PER NZS 4223 AND WINDOW SCHEDULE.

-ALL GLAZING TO BE DOUBLE GLAZED TO A MINIMUM OF RO.26, AS PER TABLE 1 IN CLAUSE H1 (EXCEPT THE GARAGE, PROVIDED THE INTERMEDIATE WALL BETWEEN GARAGE AND HOUSE IS INSULATED TO A MINIMUM R VALUE REQUIRED FOR WALLS).


EAST ELEVATION

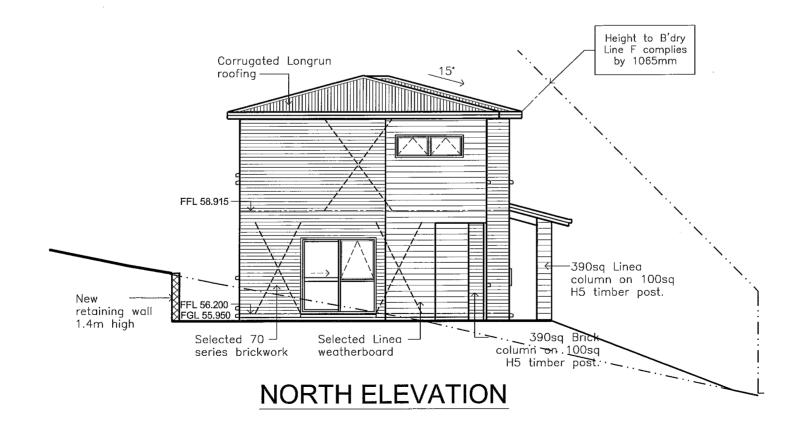

HB	Design Limited	19 NorthRidge Dr, Hamilton E-mail address: h.b.c@xtra.co.nz Ph: (07) 853 2000 Fax: (07) 853 2555
----	-------------------	---

Proposed: Lot 65 — DP 392290, 32 Alpers Ridge, River Gardens, Cambridge. Drawing Name: ELEVATION

Amendments:	Date: June 2013	No: 7
	Scale: 1:100	© COPYRIGHT

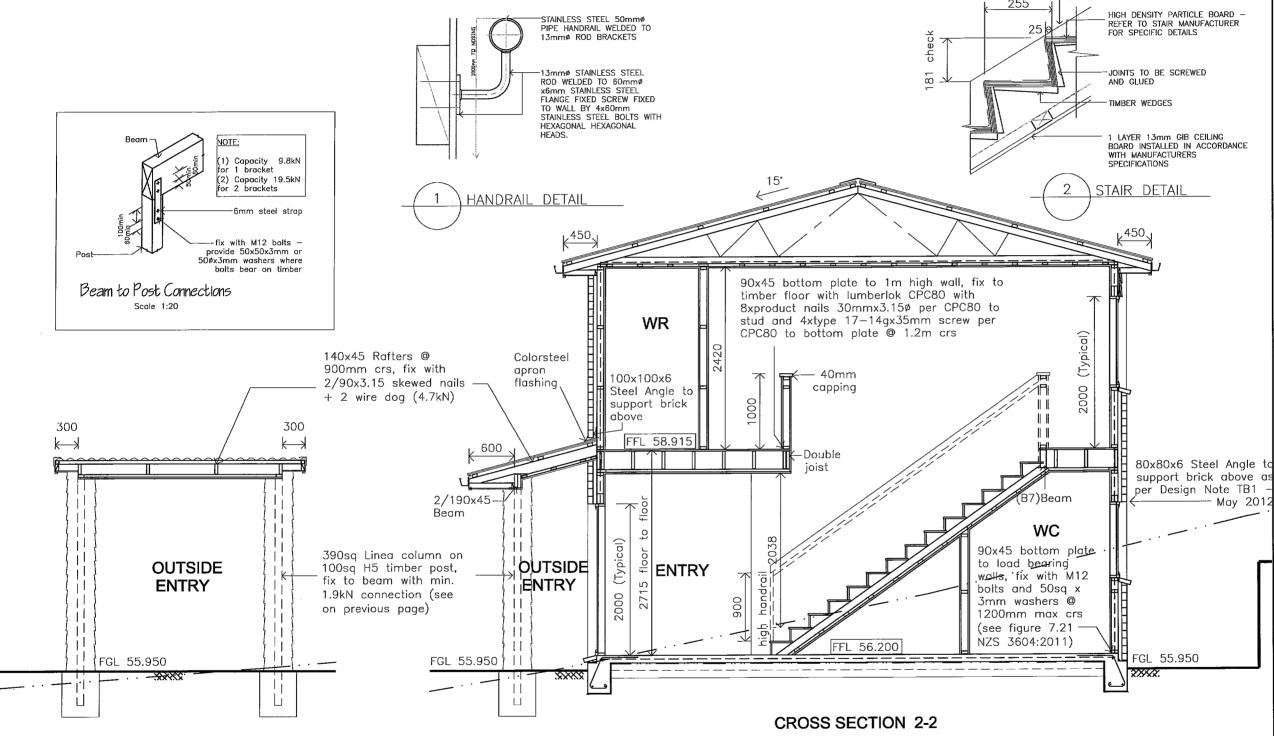

- 0.4mm BMT CORRUGATED COLORSTEEL ROOFING ON THERMORAFT 215 HEAVY WEIGHT SELF SUPPORTING BREATHER TYPE BUILDING UNDERLAY (OR SIMILAR) AS PER NZS 2295:200 OVER ON 75×50 PURLINS @ 900mm CRS (SGR) FIX TO TRUSSES WITH 2/90x3.15 POWER DRIVEN @ MAIN ROOF AREA 2/100x3.75 SKEWED NAILS & 1 WIREDOG @ PERIPHERY AREA'S (0.2xWIDTH). SEE TABLE 10.9 & 10.10, FIGURE 10.17 IN NZS
- H1.2 TIMBER TRUSSES @ 900mm CRS AND OTHER ROOF FRAMING SG8 AS PER NZS 3603:1993. TRUSSES, FIXINGS TO TOP PLATE, GIRDER TRUSS LINTEL SIZES AND ROOF LAYOUT AS PER APPROVED TRUSS MANUFACTURER'S DESIGN.
- H1.2 LINTELS (SGB) TO BE CHECKED BY PRECUT SPECIALIST TO COMPLY WITH NZS 3604:2011. PLEASE REFER TO ROOF AYOUT AS PER APPROVED MANUFACTURER'S DESIGN.
- PRE-FINISHED COLORSTEEL 1/2 ROUND GUTTER (OR SIMILAR) SYSTEM COMPLETE WITH BRACKETS @ 900mm CRS OF METAL FASCIA AND BARGE BOARD AS PER NZS 3617:1979.
- 80Ø COLORSTEEL (OR SIMILAR) DOWNPIPES COMPLETE WITH BRACKETS AS PER MANUFACTURER'S MANUAL.
- 4.5mm HARDIFLEX SOFFIT AS PER JAMES HARDIE EAVES LINING MANUAL IN PVC JOINTERS AND PAINT FINISH ON 75x40mm SPROCKETS AND SOFFIT RUNNER.
- 75X 40mm (SG8) CEILING BATTENS @ 400mm CRS AS PER NZS 3604:2011; FIX WITH 2/ 75X 3.06mm POWER DRIVEN NAILS, WITH 140X 35mm ADDITIONAL TOP PLATE OVER WALLS.
- -135mm BATT INSULATION TO A MIN. OF R3.2 TO CEILING SPACE AS PER H1 COMPLIANCE REPORT.

STAIR STRINGER

WALLS

- ALL FRAMING TO BE SGB 90x45mm H1.2 TREATED @
400mm CRS MAX AT BOTH LEVELS AS PER NZS 3603:1993
AND NZS 3604:2011, UNLESS STATED OTHERWISE.

 90mm BATT INSULATION TO A MIN. OF R2.2 TO EXTERIOR WALLS AS PER H1 COMPLIANCE REPORT. GARAGE IS NOT REQUIRED PROVIDED THE INTERMEDIATE WALL BETWEEN GARAGE AND HOUSE IS INSULATED TO THE MIN. H1 REQUIREMENTS, INLESS REQUESTED BY OWNER.

LININGS AND FINISHES

- CEILINGS ARE 13mm STANDARD GIB PLASTERBOARD, LEVEL STOPPED AND 3 COAT PAINT FINISH.
- WALLS ARE 10mm STANDARD GIB PLASTERBOARD, LEVEL 4 STOPPED AND FINISH AS PER OWNERS REQUIREMENTS.
- WALLS IN WET AREA'S ARE 10mm AQUALINE GIB PLASTERBOARD, LEVEL 4 STOPPED AND FINISH AS PER OWNERS REQUIREMENTS.
- SELECTED GIB PLASTERBOARD SCOTIA OR SQUARE STOPPED(CHECK WITH OWNER).
- -SELECTED TIMBER SKIRTING AS PER OWNERS REQUIREMENTS.
- -SELECTED TIMBER ARCHITRAVES TO WINDOWS AND INTERNAL DOORS AS/OR PER OWNERS REQUIREMENTS.

- HOUSE JOISTS ARE H1.2 240X45 JOIST @ 400MM CRS., BLOCKING AT SUPPORTS. FIX AS PER MANUFACTURER'S INSTRUCTIONS (UNLESS STATED OTHERWISE)
- -20mm HD SHEET FLOORING (OR SIMILAR), EXCEPT BATHROOM AND TOILET AREA. ALLOW H3.2 TREATED PLYWOOD SHEET FLOORING TO BATHROOM AND TOILET.

- SELECTED 70 SERIES BRICKWORK ON 50mm CAVITY ON BRANZ APPROVED TYVEK WEATHERIZATION SYSTEM (OR SIMILAR) AS PER NZS 2295:2006 ON KILN DRIED TIMBER FRAMING.
- 180mm WIDE, 16mm THICK PRE-PRIMED BEVELED-BACK LINEA WEATHERBOARDS ON 20mm CAVITY AS PER NZS 3617:1979 ON BRANZ APPROVED TYVEK WEATHERIZATION SYSTEM (OR SIMILAR) AS PER NZS 2295:2006 ON KILN DRIED TREATED TIMBER FRAMING.

- ALL JOINERY TO BE RESIDENTIAL GRADE POWDER COATED ALUMINIUM JOINERY AND HEAD FLASHINGS WITH APPROVED SEALANT AS PER NZS 4211:1985 AND AS PER MANUFACTURER DOOR AND WINDOW SCHEDULE.
- ALL GLAZING TO ACHIEVE A MIN. OF RO.26 (DOUBLE), AS PER H1 COMPLIANCE REPORT, EXCEPT IN GARAGE PROVIDED THE INTERMEDIATE WALL/CEILING BETWEEN GARAGE AND HOUSE IS INSULATED TO THE MIN. CLAUSE H1 REQUIREMENTS
- SAFETY GLAZING TO ALL BATHROOMS AS PER NZS4223 PART 3 AND AS PER MANUFACTURER'S DOOR AND WINDOW SCHEDULE


- CONCRETE FOOTING (20Mpg) AS PER FOOTING DETAIL, DIGOUT ND COMPACT SAND AS PER ENGINEER'S SOIL REPORT.
- FLOOR TO BE 100mm CONCRETE FLOOR (17.5Mpa) TO A MIN.OF R1.3, 500E DUCTILE MESH (OR GRADE 300E -- D12 @ 450MM CRS EACH WAY -- CONFORMING WITH AS/NZS4671 35mm COVER) ON APPROVED 0.25mm POLYTHENE DPM, ON MIN. 100 mm
- CHECK ALL GROUND LEVELS AND MIN. FLOOR HEIGHT ON SITE RIOR TO COMMENCING CONSTRUCTION.



CROSS SECTION 1-1

Proposed: Lot 65 - DP 392290, 32 Alpers Ridge, River Gardens, Cambridge.

Amendments: Drawing Name: 8 June 2013 CROSS SECTIONS © COPYRIGHT

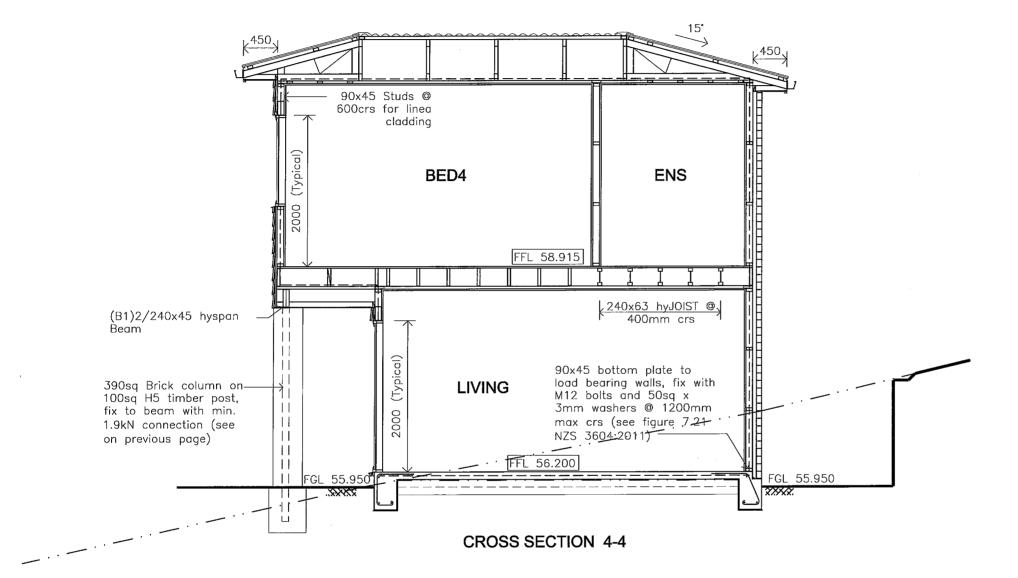

- O.4mm BMT CORRUGATED COLORSTEEL ROOFING ON THERMOKRAFT 215 HEAVY WEIGHT SELF SUPPORTING BREATHER TYPE BUILDING UNDERLAY (OR SIMILAR) AS PER NZS 2295:200 OVER ON 75×50 PURLINS @ 900mm CRS (SGB), FIX TO TRUSSES WITH 2/90x3.15 POWER DRIVEN @ MAIN ROOF AREA, 2/100x3.75 SKEWED NAILS & 1 WIREDOG @ PERIPHERY AREA'S 0.2xWIDTH). SEE TABLE 10.9 & 10.10, FIGURE 10.17 IN NZS
- H1.2 TIMBER TRUSSES @ 900mm CRS AND OTHER ROOF FRAMING SG8 AS PER NZS 3603:1993. TRUSSES, FIXINGS TO TOP PLATE, GIRDER TRUSS LINTEL SIZES AND ROOF LAYOUT AS PER APPROVED TRUSS MANUFACTURER'S DESIGN.
- H1.2 LINTELS (SG8) TO BE CHECKED BY PRECUT SPECIALIST TO COMPLY WITH NZS 3604:2011. PLEASE REFER TO ROOF LAYOUT AS PER APPROVED MANUFACTURER'S DESIGN.
- PRE-FINISHED COLORSTEEL 1/2 ROUND GUTTER (OR SIMILAR) SYSTEM COMPLETE WITH BRACKETS @ 900mm CRS ON METAL FASCIA AND BARGE BOARD AS PER NZS 3617:1979.
- 800 COLORSTEEL (OR SIMILAR) DOWNPIPES COMPLETE WITH BRACKETS AS PER MANUFACTURER'S MANUAL.
- 4.5mm Hardiflex Soffit as Per James Hardie Eaves Lining Manual in PVC Jointers and Paint Finish on 75x40mm SPROCKETS and SOFFIT RUNNER.
- 75X 40mm (SG8) CEILING BATTENS @ 400mm CRS AS PER NZS 3604:2011; FIX WITH 2/ 75X 3.06mm POWER DRIVEN NAILS, WITH 140X 35mm ADDITIONAL TOP PLATE OVER WALLS.
- -135mm BATT INSULATION TO A MIN. OF R3.2 TO CEILING SPACE AS PER H1 COMPLIANCE REPORT.

WALLS

- ALL FRAMING TO BE SG8 90x45mm H1.2 TREATED ©
400mm CRS MAX AT BOTH LEVELS AS PER NZS 3603:1993
AND NZS 3604:2011, UNLESS STATED OTHERWISE.

90mm BATT INSULATION TO A MIN. OF R2.2 TO EXTERIOR WALLS AS PER HI COMPLIANCE REPORT, GARAGE IS NOT REQUIRED PROVIDED THE INTERMEDIATE WALL BETWEEN GARAGE AND HOUSE IS INSULATED TO THE MIN. HI REQUIREMENTS, UNITES REQUESTED BY OWNER.

LININGS AND FINISHES

- CEILINGS ARE 13mm STANDARD GIB PLASTERBOARD, LEVEL STOPPED AND 3 COAT PAINT FINISH.

- WALLS ARE 10mm STANDARD GIB PLASTERBOARD, LEVEL 4 STOPPED AND FINISH AS PER OWNERS REQUIREMENTS.
- WALLS IN WET AREA'S ARE 10mm AQUALINE GIB PLASTERBOARD, LEVEL 4 STOPPED AND FINISH AS PER OWNERS REQUIREMENTS.
- SFLECTED GIB PLASTERBOARD SCOTIA OR SQUARE STOPPED(CHECK WITH OWNER).
- -SELECTED TIMBER SKIRTING AS PER OWNERS REQUIREMENTS.
- -selected timber architraves to windows and internal doors as/or per owners requirements.

- HOUSE JOISTS ARE H1.2 240X45 JOIST @ 400MM CRS., BLOCKING AT SUPPORTS. FIX AS PER MANUFACTURER'S INSTRUCTIONS (UNLESS STATED OTHERWISE)
- -20mm HD SHEET FLOORING (OR SIMILAR), EXCEPT BATHROOM AND TOILET AREA. ALLOW H3.2 TREATED PLYWOOD SHEET FLOORING TO BATHROOM AND TOILET.

WALL CLADDING

– SELECTED 70 SERIES BRICKWORK ON 50mm CAVITY ON BRANZ APPROVED TYVEK WEATHERIZATION SYSTEM (OR SIMILAR) AS PER NZS 2295:2006 ON KILN DRIED TIMBER FRAMING.

- 180mm WIDE, 16mm THICK PRE-PRIMED BEVELED-BACK LINEA WEATHERBOARDS ON 20mm CAVITY AS PER NZS 3617:1979 ON BRANZ APPROVED TYVEK WEATHERIZATION SYSTEM (OR SIMILAR) AS PER NZS 2295:2006 ON KILN DRIED TREATED TIMBER FRAMING.

- ALL JOINERY TO BE RESIDENTIAL GRADE POWDER COATED ALUMINIUM JOINERY AND HEAD FLASHINGS WITH APPROVED SEALANT AS PER NZS 4211:1985 AND AS PER MANUFACTURER' DOOR AND WINDOW SCHEDULE.
- ALL GLAZING TO ACHIEVE A MIN. OF RO.26 (DOUBLE), AS PER H1 COMPLIANCE REPORT, EXCEPT IN GARAGE PROVIDED THE INTERMEDIATE WALL/CEILING BETWEEN GARAGE AND HOUSE IS INSULATED TO THE MIN. CLAUSE H1 REQUIREMENTS
- SAFETY GLAZING TO ALL BATHROOMS AS PER NZS4223 PART 3 AND AS PER MANUFACTURER'S DOOR AND WINDOW SCHEDULE


- CONCRETE FOOTING (20Mpg) AS PER FOOTING DETAIL, DIGOUT AND COMPACT SAND AS PER ENGINEER'S SOIL REPORT.
- FLOOR TO BE 100mm CONCRETE FLOOR (17.5Mpa) TO A MIN.OF R1.3, 500E DUCTILE MESH (OR GRADE 300E D12 @ 450MM CRS EACH WAY CONFORMING WITH AS/NZS4671 35mm COVER) ON APPROVED 0.25mm POLYTHENE DPM, ON MIN. 100 mm COMPACTED SAND BACKFILL.
- CHECK ALL GROUND LEVELS AND MIN. FLOOR HEIGHT ON SITE PRIOR TO COMMENCING CONSTRUCTION.



Proposed: Lot 65 - DP 392290, 32 Alpers Ridge, River Gardens, Cambridge.

Drawing Name: CROSS SECTIONS

Amendments:	June 2013	No: 9
	Scale: 1:50	© COPYRIGHT

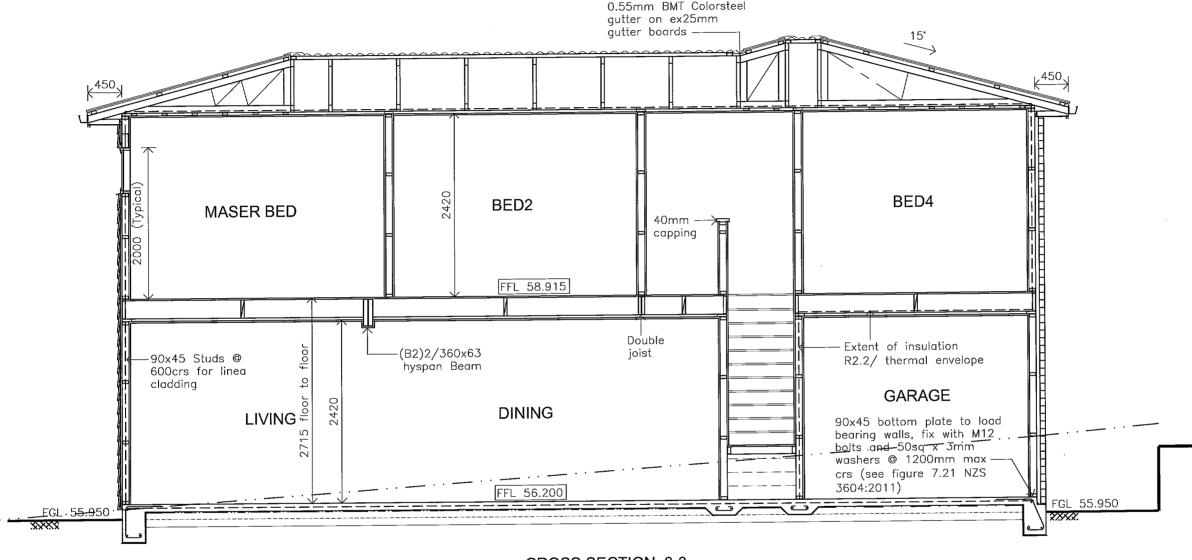

CROSS SECTION 3-3

HBC Design E-mail address: h.b.c@xtra.co.nz Ph: (07) 853 2000 Fax: (07) 853 2555

Proposed: Lot 65 - DP 392290, 32 Alpers Ridge, River Gardens, Cambridge. Drawing Name: CROSS SECTIONS

- CHECK ALL GROUND LEVELS AND MIN. FLOOR HEIGHT ON SITE PRIOR TO COMMENCING CONSTRUCTION. Amendments: 10 June 2013 Scale: © COPYRIGHT 1:50

- ALL JOINERY TO BE RESIDENTIAL GRADE POWDER COATED ALLOMINIUM JOINERY AND HEAD FLASHINGS WITH APPROVED SEALANT AS PER NZS 4211:1985 AND AS PER MANUFACTURER'S DOOD AND IMPROVE GUESTIFE. DOOR AND WINDOW SCHEDULE.

OVER ON 75x50 PURLINS @ 900mm CRS (SG8), FIX TO TRUSSES WITH 2/90x3.15 POWER DRIVEN @ MAIN ROOF AREA. 2/100x3.75 SKEWED NAILS & 1 WIREDOG ® PERIPHERY AREA'S (0.2xWIDTH). SEE TABLE 10.9 & 10.10, FIGURE 10.17 IN NZS

H1.2 TIMBER TRUSSES @ 900mm CRS AND OTHER ROOF FRAMING SG8 AS PER NZS 3603:1993. TRUSSES, FIXINGS TO TOP PLATE, GIRDER TRUSS LINTEL SIZES AND ROOF LAYOUT AS

- H1.2 LINTELS (SG8) TO BE CHECKED BY PRECUT SPECIALIST TO COMPLY WITH NZS 3604:2011. PLEASE REFER TO ROOF LAYOUT AS PER APPROVED MANUFACTURER'S DESIGN.

- PRE-FINISHED COLORSTEEL 1/2 ROUND GUTTER (OR SIMILAR) SYSTEM COMPLETE WITH BRACKETS ⊚ 900mm CRS ON METAL FASCIA AND BARGE BOARD AS PER NZS 3617:1979. 800 COLORSTEEL (OR SIMILAR) DOWNPIPES COMPLETE WITH

4.5mm HARDIFLEX SOFFIT AS PER JAMES HARDIE EAVES LINING MANUAL IN PVC JOINTERS AND PAINT FINISH ON 75x40mm SPROCKETS AND SOFFIT RUNNER.

-135mm BATT INSULATION TO A MIN. OF R3.2 TO CEILING SPACE AS PER H1 COMPLIANCE REPORT.

WALLS

- ALL FRAMING TO BE SG8 90x45mm H1.2 TREATED

400mm CRS MAX AT BOTH LEVELS AS PER NZS 3603:1993

AND NZS 3604:2011, UNLESS STATED OTHERWISE.

— 90mm BATT INSULATION TO A MIN. OF R2.2 TO EXTERIOR WALLS AS PER H1 COMPLIANCE REPORT. GARAGE IS NOT REQUIRED PROVIDED THE INTERMEDIATE WALL BETWEEN GARAGE AND HOUSE IS INSULATED TO THE MIN. H1 REQUIREMENTS, UNLESS REQUESTED BY OWNER.

CEILINGS ARE 13mm STANDARD GIB PLASTERBOARD, LEVEL STOPPED AND 3 COAT PAINT FINISH.

WALLS ARE 10mm STANDARD GIB PLASTERBOARD, LEVEL 4 STOPPED AND FINISH AS PER OWNERS REQUIREMENTS.

-SELECTED TIMBER SKIRTING AS PER OWNERS REQUIREMENTS.

-SELECTED TIMBER ARCHITRAVES TO WINDOWS AND INTERNAL

HOUSE JOISTS ARE H1.2 240X45 JOIST @ 400MM CRS.,

-20mm HD SHEET FLOORING (OR SIMILAR), EXCEPT BATHROOM AND TOILET AREA. ALLOW H3.2 TREATED PLYWOOD SHEET FLOORING TO BATHROOM AND TOILET.

SELECTED 70 SERIES BRICKWORK ON 50mm CAVITY ON

BRANZ APPROVED TYVEK WEATHERIZATION SYSTEM (OR SIMILAR) AS PER NZS 2295:2006 ON KILN DRIED TIMBER FRAMING.

- 180mm WIDE, 16mm THICK PRE-PRIMED BEVELED-BACK LINEA WEATHERBOARDS ON 20mm CAVITY AS PER NZS 3617:1979 ON BRANZ APPROVED TYVEK WEATHERIZATION SYSTEM (OR SIMILAR) AS PER NZS 2295:2006 ON KILN DRIED TREATED TIMBER FRAMING.

BLOCKING AT SUPPORTS. FIX AS PER MANUFACTURER'S

WALLS IN WET AREA'S ARE 10mm AQUALINE GIB
 PLASTERBOARD, LEVEL 4 STOPPED AND FINISH AS PER

SELECTED GIB PLASTERBOARD SCOTIA OR SQUARE

DOORS AS/OR PER OWNERS REQUIREMENTS.

INSTRUCTIONS (UNLESS STATED OTHERWISE)

LININGS AND FINISHES

OWNERS REQUIREMENTS.

MID-FLOOR

STOPPED(CHECK WITH OWNER).

-- 75X 40mm (SG8) CEILING BATTENS @ 400mm CRS AS PER NZS 3604:2011; FIX WITH 2/ 75X 3.06mm POWER DRIVEN NAILS, WITH 140X 35mm ADDITIONAL TOP PLATE OVER WALLS.

PER APPROVED TRUSS MANUFACTURER'S DESIGN.


BRACKETS AS PER MANUFACTURER'S MANUAL.

- ALL GLAZING TO ACHIEVE A MIN. OF RO.26 (DOUBLE), AS PER H1 COMPLIANCE REPORT, EXCEPT IN GARAGE PROVIDED THE INTERMEDIATE WALL/CEILING BETWEEN GARAGE AND HOUSE IS INSULATED TO THE MIN. CLAUSE H1 REQUIREMENTS
- SAFETY GLAZING TO ALL BATHROOMS AS PER NZS4223 PART AND AS PER MANUFACTURER'S DOOR AND WINDOW SCHEDULE


CONCRETE

JOINERY


- concrete footing (20Mpg) as Per Footing Detail. Digout and compact sand as Per Engineer's soil report.
- FLOOR TO BE 100mm CONCRETE FLOOR (17.5Mpa) TO A MIN.OF R1.3, 500E DUCTILE MESH (OR GRADE 300E D12 @ 450MM CRS EACH WAY CONFORMING WITH AS/NZS4671 35mm COVER) ON APPROVED 0.25mm POLYTHENE DPM, ON MIN. 100 mm COMPACTED SAND BACKFILL.

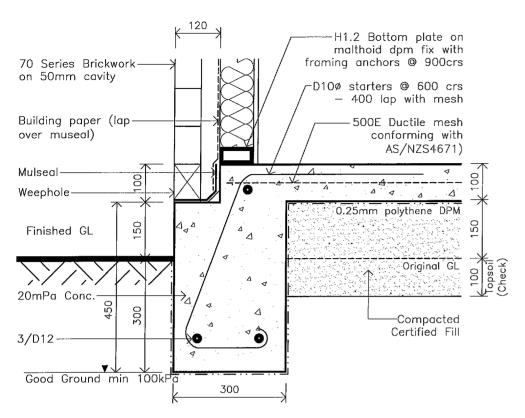


1 FOUNDATION DETAIL POURED CONCRETE

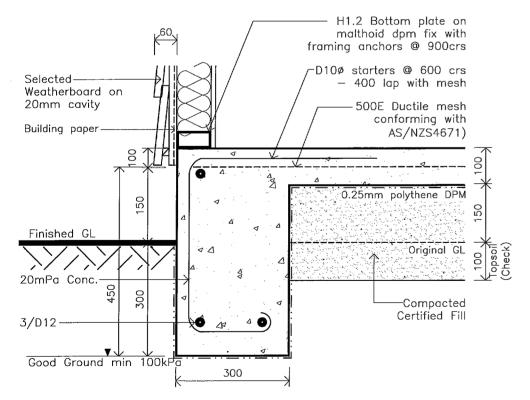

② FOUNDATION DETAIL POURED CONCRETE

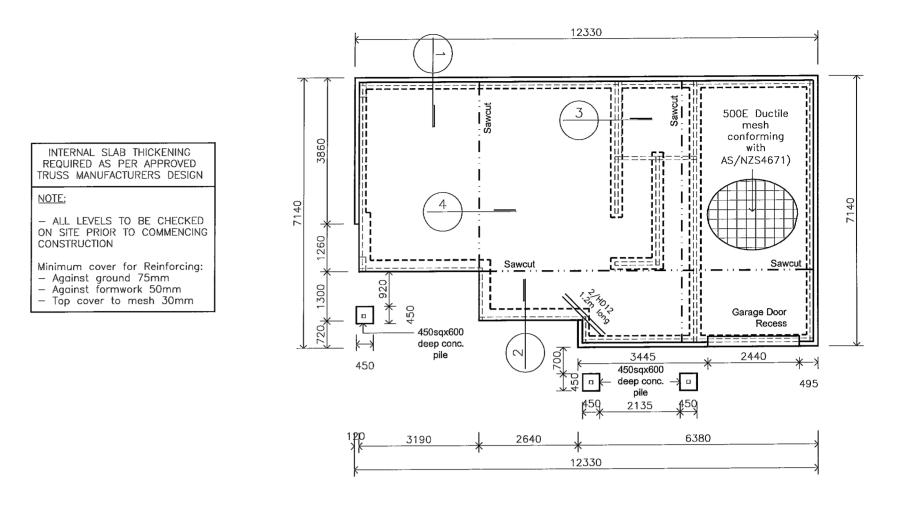

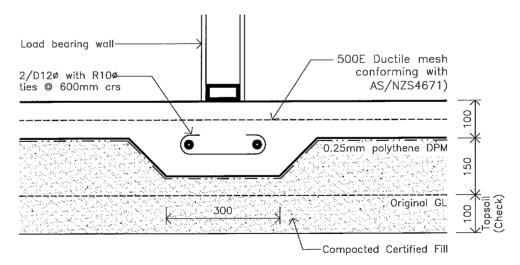

3 SECTION THRU FOOTING AT LOAD BEARING WALL (STRIP FOOTING)

0.25mm Polythene (or similar approved) DPC, 150mm lap to joint's.

(4) SAWCUT DETAIL



Proposed: Lot 65 — DP 392290, 32 Alpers Ridge, River Gardens, Cambridge.

Drawing Name:
FOUNDATION PLAN
AND DETAILS

500E Ductile mesh-

conforming with

AS/NZS4671)


Amendments:	Date: June 2013	No: 11
	Scale: 1:100, 1:10	© COPYRIGHT

25x5mm Saw cut

equal sealant

filled @ latest possible

stage with FOSROC or

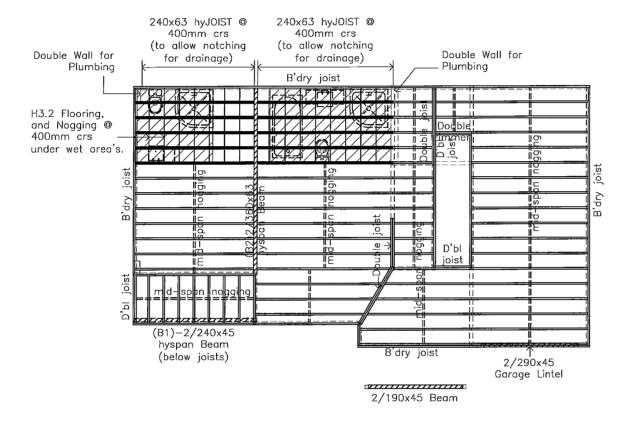

NOTE'S:

- ALL DRAWINGS ARE TO BE READ IN CONJUNCTION WITH ENGINEER'S CALCULATIONS AND DRAWINGS
- ALL TIMBER IS SG8 (UNLESS STATED OTHERWISE).
- HOUSE JOISTS ARE H1.2 240x45 SG8 JOIST @ 400mm CRS.


TIMBER TREATMENTS:


- ALL TIMBERS ARE SG8, UNLESS STATED OTHERWISE.
- ALL TIMBERS ARE H1.2 TREATED AS
 PER TABLE 1A B2/AS1, EXCEPT:
 * DRAINAGE CAVITY BATTERNS ARE H3.1.
- * DRAINAGE CAVITY BATTERNS ARE HE * ANY EXPOSED OR CANTILEVERED
- MEMBER'S ARE H3.2. * ANY POST'S OR PILES IN CONTACT WITH THE GROUND ARE H5.

Proposed: Lot 65 — DP 392290, 32 Alpers Ridge, River Gardens, Cambridge.


Drawing Name:
FLOOR JOIST LAYOUT

Amendments:	June 2013	No: 12
	Scale: 1:100	© COPYRIGHT

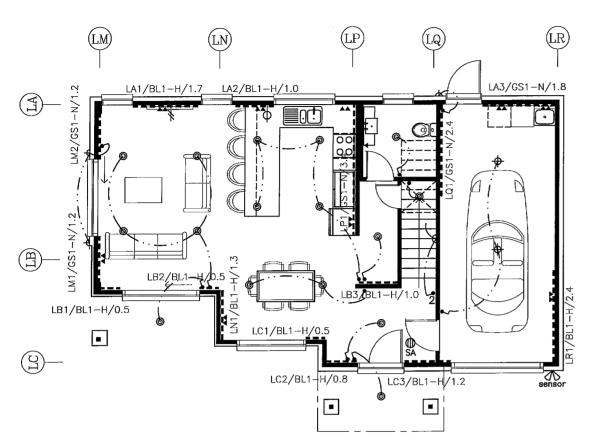

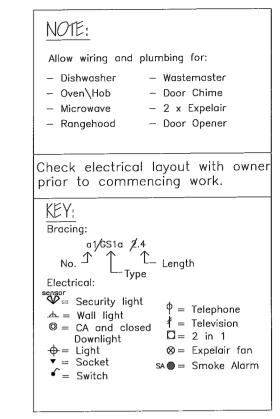

GROUND FLOOR PLAN

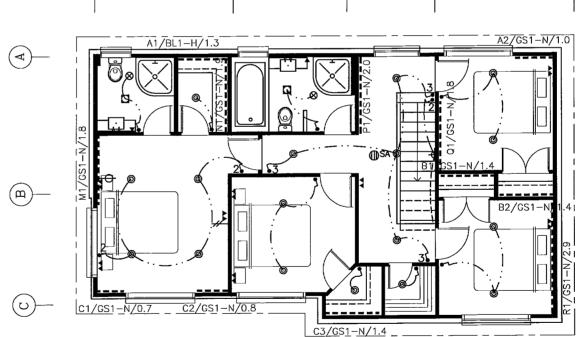


FIRST FLOOR PLAN



Proposed: Lot 65 — DP 392290, 32 Alpers Ridge, River Gardens, Cambridge.

Drawing Name:
BRACING AND
ELECTRICAL PLAN

Amendments:	Date: June 2013	No: 13
	Scale: 1:100	© COPYRIGHT

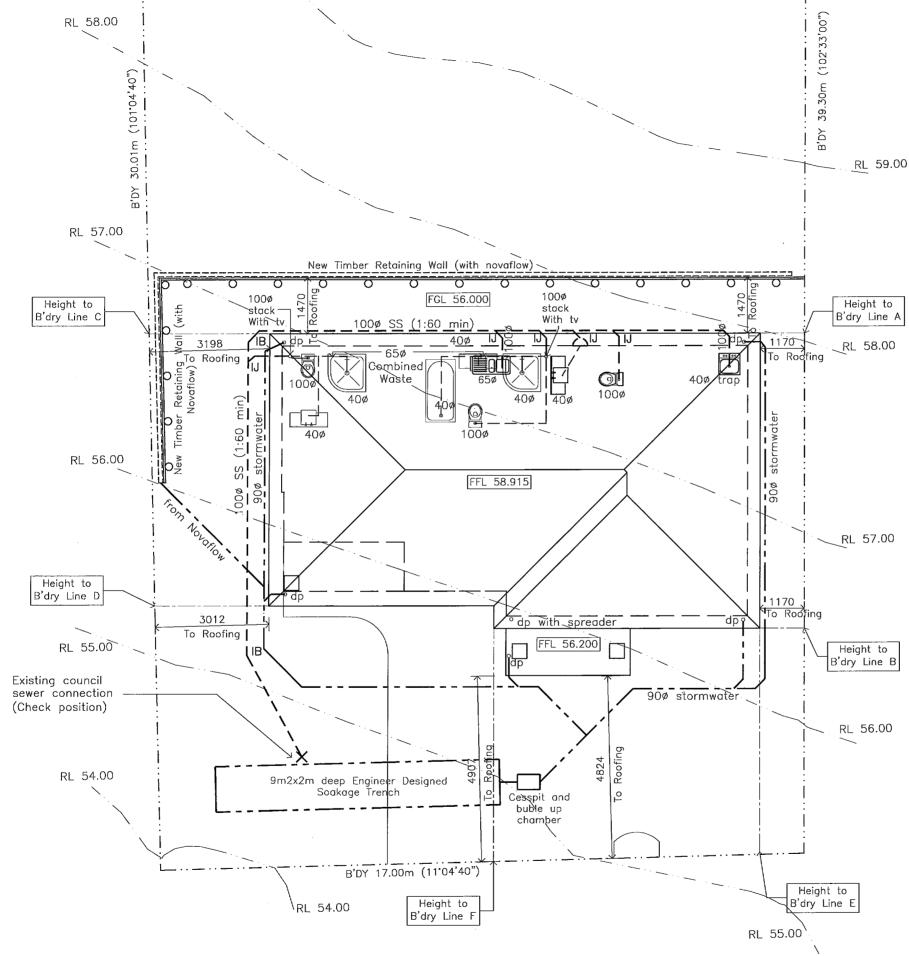



Lot 65 - DP 392290

<u>NOTE:</u>

- ALL LEVELS TO BE CHECKED ON SITE PRIOR TO COMMENCING CONSTRUCTION
- ALL PLUMBING TO COMPLY WITH AS/NZS 3500 - FOWL WATER. AND TO HAVE INTERNAL GRADIENTS OF
- 1:40 FOR UP TO 80ø 1:60 FOR OVER 80ø
- ALL FLOORING TO BATHROOM AND TOILET SHALL BE H3.1 TREATED PLYWOOD SHEET
- CHECK POSITION OF DWELLING WITH OWNER PRIOR TO COMMENCING CONSTRUCTION
- -CHECK POSITION OF SEWER AND STORMWATER PRIOR TO COMMENCING CONSTRUCTION.




Proposed: Lot 65 — DP 392290, 32 Alpers Ridge, River Gardens, Cambridge.

Drawing Name:

DRAINAGE AND
SITE PLAN


Amendments:	June 2013	No: 14
	Scale: 1:100	© COPYRIGHT

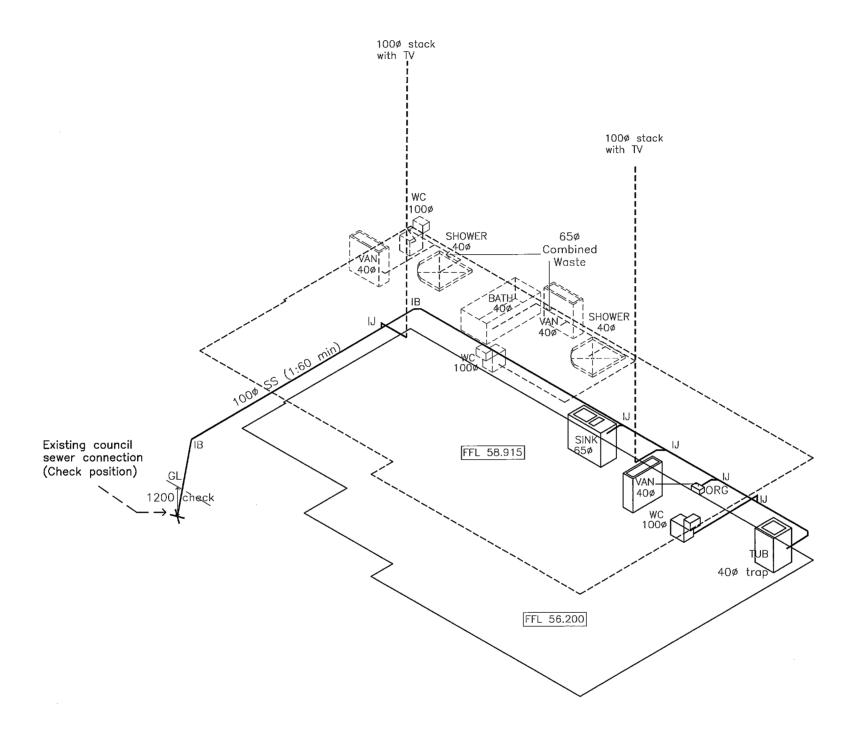


HBC Design E-m	19 NorthRidge Dr. Hamilton noil address: h.b.@xira.co.nz Ph: (07) 853 2000 Fax: (07) 853 2555
----------------	---


Proposed: Lot 65 — DP 392290, 32 Alpers Ridge, River Gardens, Cambridge. Drawing Name:
ISOMETRIC PLUMBING


Amendments:	Date: June 2013	No: 15
	Scale: 1:100	© COPYRIGHT

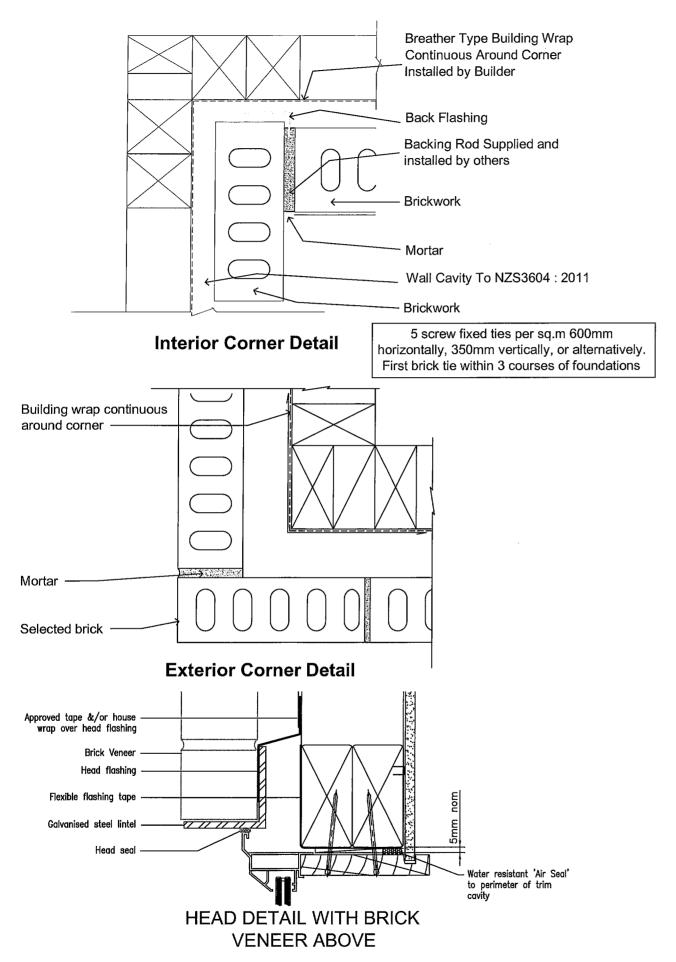


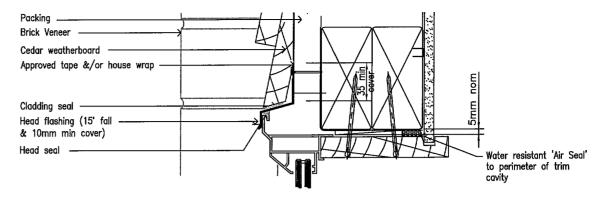

HEAD DETAIL WITH TIMBER SELECTED W'BOARD CLADDING ABOVE

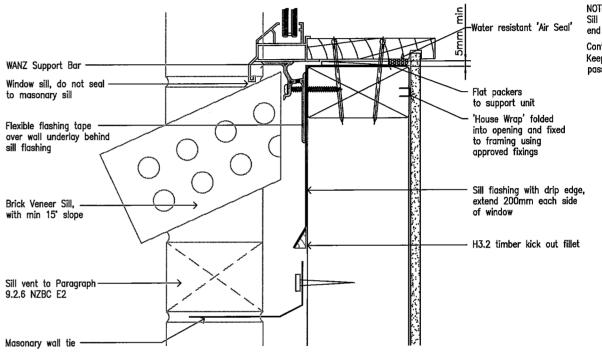

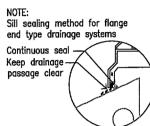

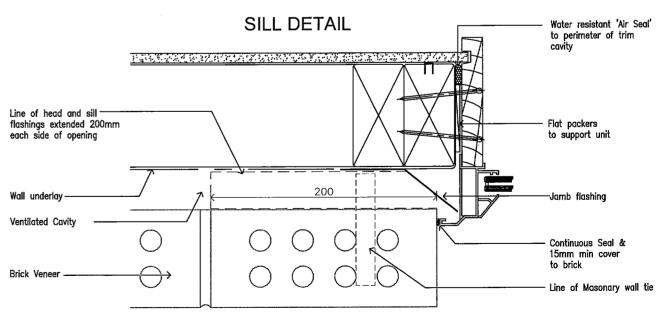


JAMB DETAIL



Proposed: Lot 65 — DP 392290, 32 Alpers Ridge, River Gardens, Cambridge. Drawing Name:
BRICKWORK DETAILS

Amendments:	June 2013	^{N₀:} D1
	scale: N.T.S.	© COPYRIGHT

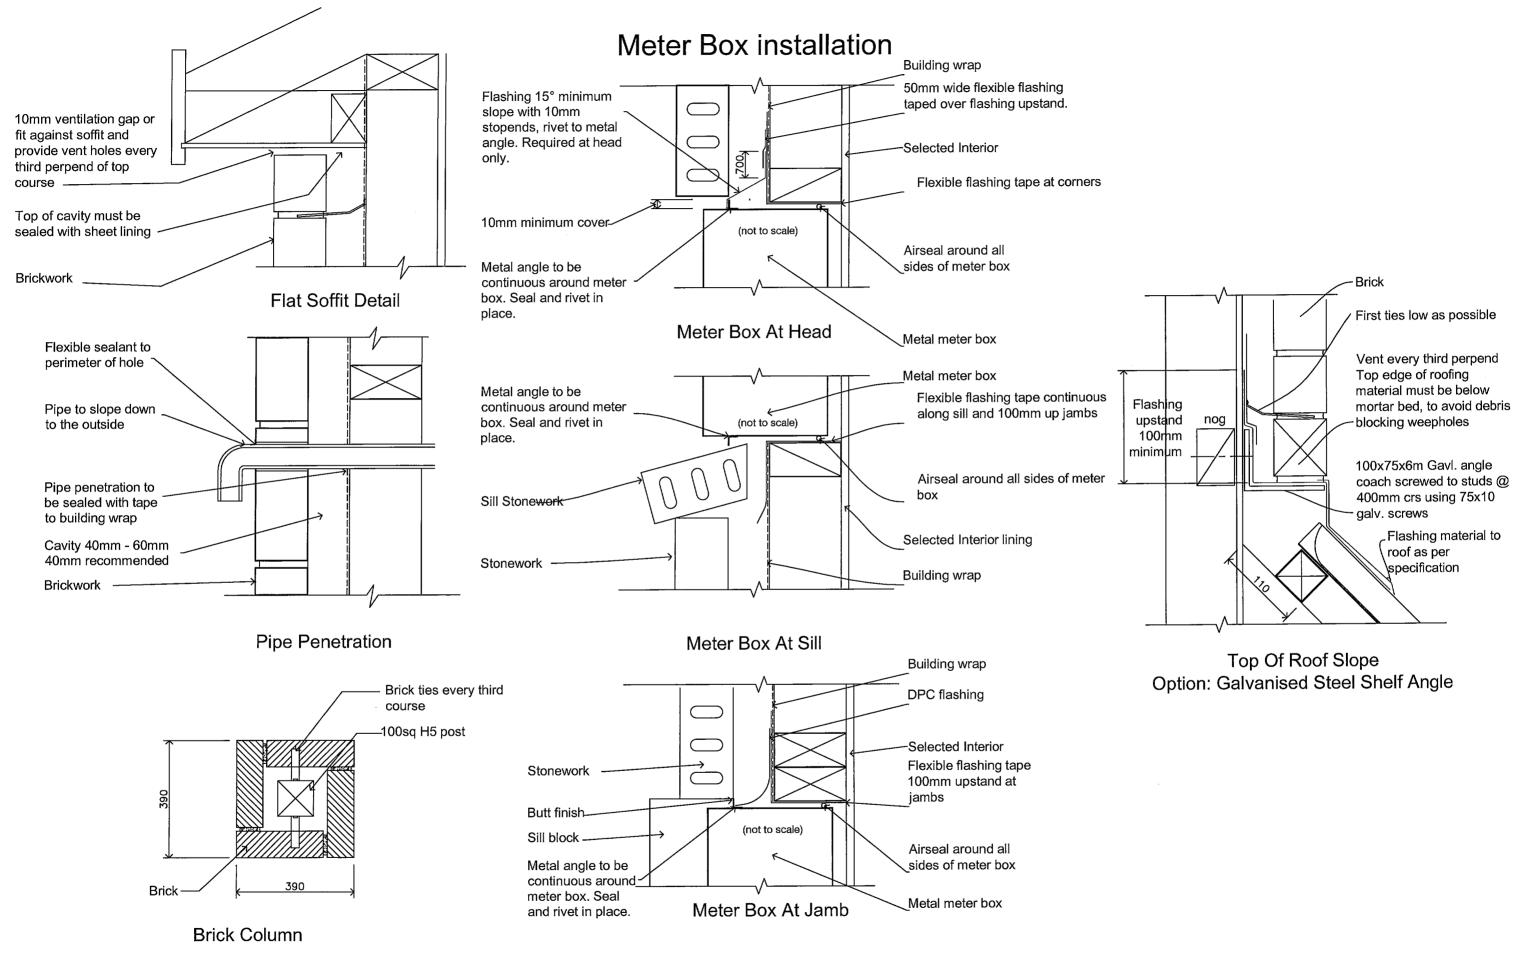





Proposed: Lot 65 — DP 392290, 32 Alpers Ridge, River Gardens, Cambridge. Drawing Name:
BRICKWORK DETAILS

Amendments:	June 2013	No: D2
	Scale: N.T.S.	© COPYRIGHT

PLAN JUNCTION BETWEEN LINEA WEATHERBOARD OR AND BRICK VENEER

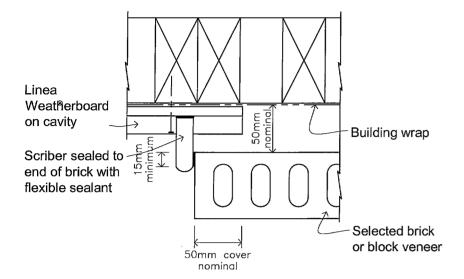



Note: Brick tie to be fixed 70mm minimum from the edge of brick to suit the cladding overlap

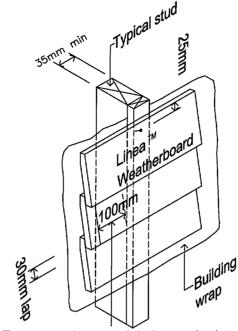


Tongue and groove join in weatherboard to be 100mm minimum from side of stud. Joints must be staggered by 600mm min


Jointing Off Stud

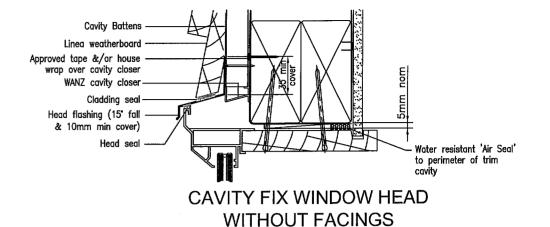

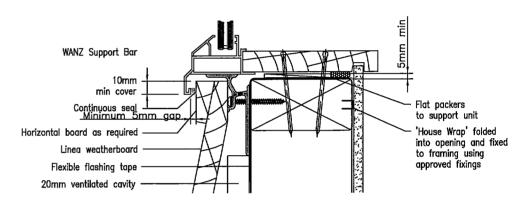

CAVITY FIX WINDOW SILL WITHOUT FACINGS

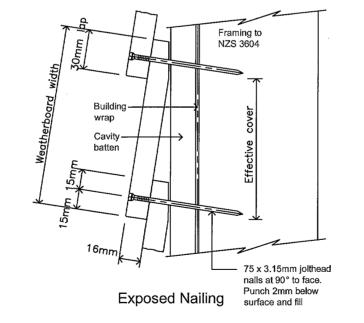

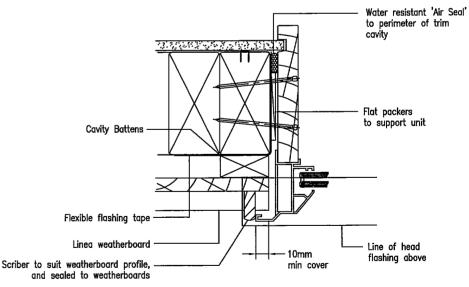

CAVITY FIX WINDOW JAMB
WITHOUT FACINGS

AND BRICK VENEER

50mm

nominal

INTERNAL CORNER JUNCTION

BETWEEN LINEA WEATHERBOARD

Weatherboard on cavity

Scriber sealed to end of brick with flexible sealant

Selected brick or block veneer

Linea




Proposed: Lot 65 — DP 392290, 32 Alpers Ridge, River Gardens, Cambridge.


Drawing Name:	
JUNCTION AND	
W'BOARD DETAILS	

Amendments:	June 2013	No: D3
	Scale: N.T.S.	© COPYRIGHT

Aluminium


Stainless steel

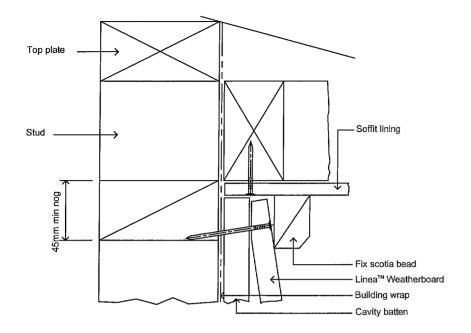

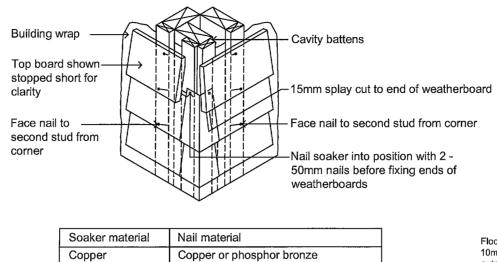



Hot dip galvanised

Stainless steel

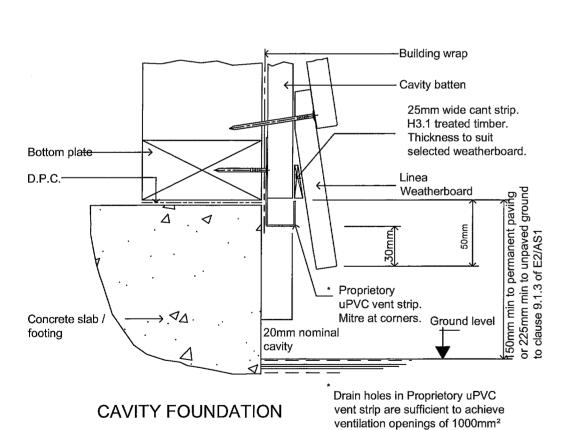

per lineal metre

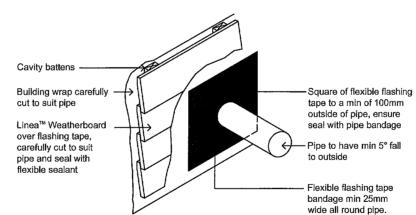

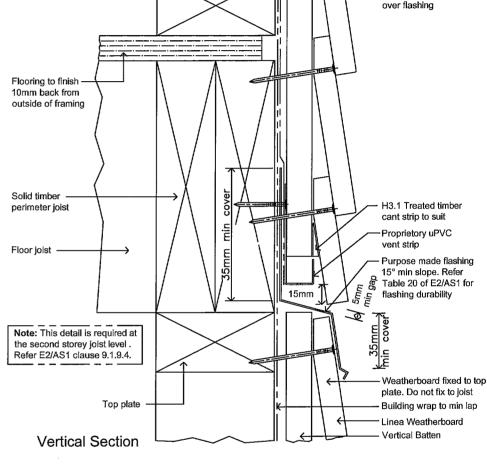

Bottom plate

	H	B	C	Design Limited	19 NorthRidge Dr, Hamilton E-mail address: h.b.e@xtra.co.nz Ph: (07) 853 2000 Fax: (07) 853 2555


Proposed: Lot 65 — DP 392290, 32 Alpers Ridge, River Gardens, Cambridge. Drawing Name:
W'BOARD DETAILS

Amendments:	Date: June 2013	No: D4
	Scale: N.T.S.	© COPYRIGHT

Vertical Batten

Linea Weatherboard

-Building wrap lap

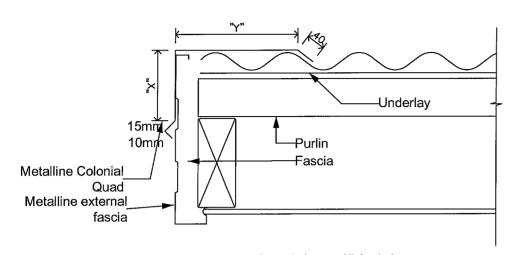


Low wind zone High wind zone


X 50mm 75mm

Y 2 corrugations 3 corrugations


This detail is used for: Corrugate Side Barge Detail Metalline Fascia

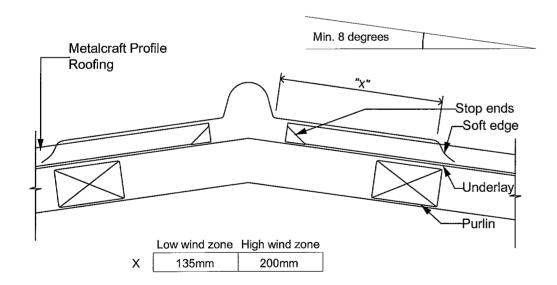

This detail is used for: Corrugate Round Top Ridge Detail

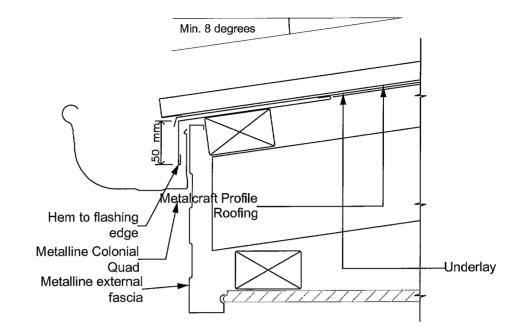

This detail is used for: Corrugate Gutter Flashing Detail Metalline Fascia with Spring Clip

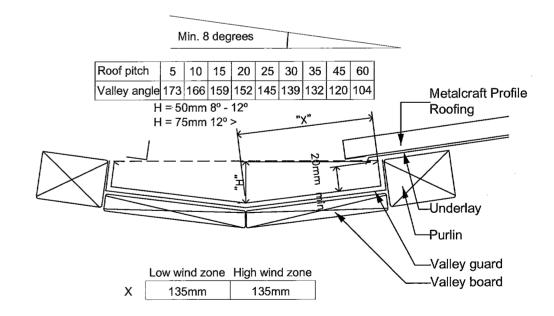


This detail is used for: Corrugate Valley Flashing Detail




Proposed:	Lot 65 - DP 392290,
	32 Alpers Ridge,
	River Gardens, Cambridge.

Drawing Name:	Amendments:
ROOFING DETAILS	


Amendments:	Date: June 2013	No: D5
	scale: N.T.S.	© COPYRIGHT

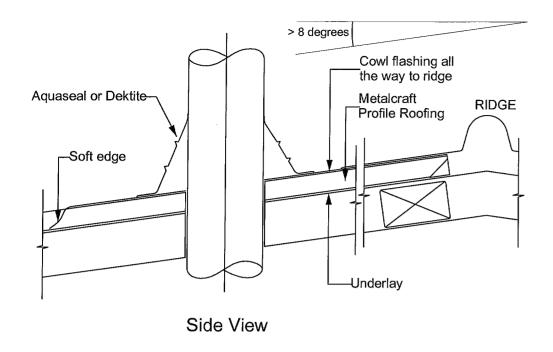


This detail is used for: Corrugate Metalline Fascia with Spring Clip

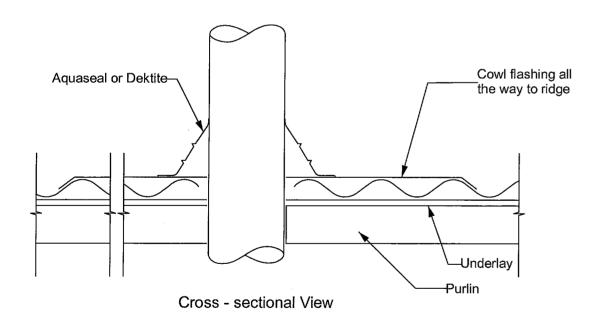

This detail is used for: Corrugate Pipe penetration Detail

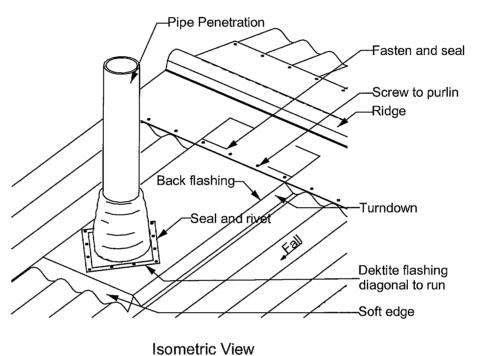


This detail is used for: Corrugate Pipe penetration Detail

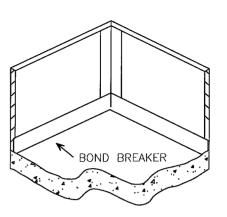

(DIAGRAM:A) FLOOR & WALL JUNCTION

2 COATS OF WET-SEAL (BRANZ APPRAISAL CERTIFICATE No. 372 (2000)) APPLIED TO A MINIMUM FINAL DRY FILM THICKNESS OF 1.5mm (ie.2@1mm WET COATS)

(DIAGRAM:B) FLOOR SHEETING & WALL BOARD JUNCTION

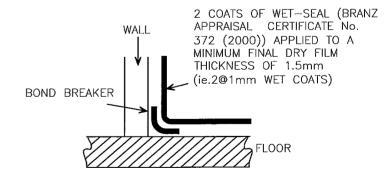

(DIAGRAM:C) FLOOR & WALL JUNCTION



Proposed:	1: Lot 65 — DP 392290, 32 Alpers Ridge,	
	32 Alpers Ridge,	
	River Gardens, Cambridge.	

orawing Name:
ROOFING AND WET
area details

Amendments:	Date: June 2013	No: D6
	Scale: N.T.S.	© COPYRIGHT